
NB-0315GSTD

NON ELEVATED 3 ROW x 15'-0" BLEACHER

National Recreation Systems, Inc.

1300-D NORTH AIRPORT OFFICE PARK FORT WAYNE, IN 46825

CS.1 — COVER SHEET
TD.1 — BLEACHER SEATING PLAN
FP.1 — FOUNDATION PLAN
AP.1 — ANCHORING PLAN
AP.2 — ANCHORING PLAN
BA.1 — BLEACHER ASSEMBLY
PF.1 — PLANK & FRAMING PLAN

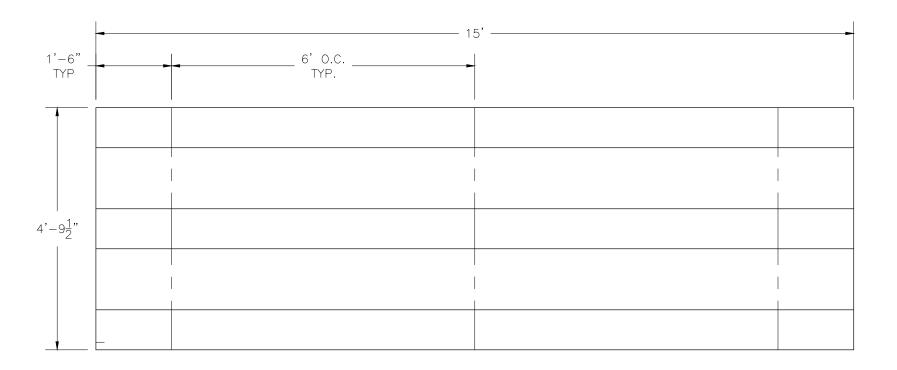

SECTION GROSS ACTUAL NO. OF NET LENGTH SEATS SEATS ROWS SEATS 10.00 10.00 3 **NET SEATS** 30 WHEELCHAIR SPACES TOTAL NET SEATING CAPACITY (BASED ON 18" PER SEAT)


This drawing and all information contained herein is the property of NATIONAL RECREATION SYSTEMS, INC. and is not to be reproduced without express written permission of this manufacturer. We assume no responsibility for unauthorized use of this drawing. National Recreation Systems, Inc. is not responsible for local permits and occupancy requirements.

National Recreation Systems, Inc.

1300-D NORTH AIRPORT OFFICE PARK FORT WAYNE, IN 46825

SCALE: N.T.S. APPROVED BY: DATE: 8/8/16

NON ELEVATED 3 ROW x 15'-0" BLEACHER SEATING PLAN BLEACHER MODEL #: NB-0315GSTD

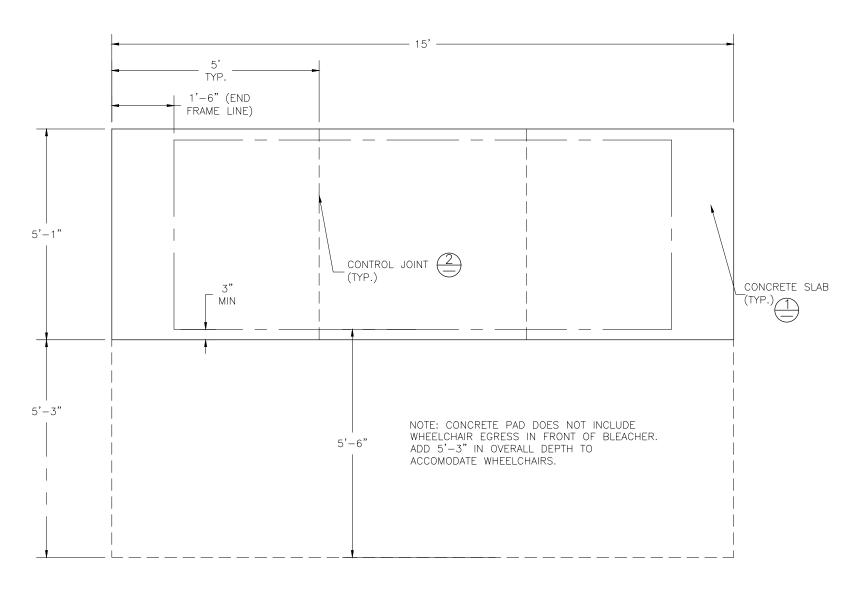

CONCRETE FOUNDATION SPECIFICATIONS

SCOPE:

Foundation construction is not part of National Recreation Systems, Inc.'s (NRS) scope of work unless noted otherwise in the contract documents. The owner shall review the foundation design with the local code authorities, and coordinate with NRS.

FOUNDATION DESIGN & ANCHORS:


- 1) The foundation designs are based on the following:
- a. Minimum presumed soil bearing 1000 psf.
- b. Bleacher frame dead and live load 700 lbs./ft. c. Bleacher frame wind uplift load 250 lbs./ft.
- 2) Unless otherwise noted on the drawings the bleacher frames shall be attached to the concrete with 3/8" dia. x 3" wedge type expansion anchors. The anchors shall be embedded a minimum of 2" into the concrete.

CONCRETE SPECIFICATIONS:

- 1) All concrete construction shall be in accordance with ACI 318-08.
- 2) All concrete shall have a minimum 28-day strength of Fc=3000 psi.
- 3) A 1/4" bituminous expansion joint material shall be placed between strip and slab foundations when adjacent to each other.
- 4) The depressions in the top of the foundations between high spots shall not exceed 5/16" below a 10-foot long straightedge. The 10-foot straightedge method used to measure foundation flatness shall be in accordance with Section of ACI 302.1R-04 "Guide for Concrete Floor and Slab Construction".

CONCRETE SLAB SPECIFICATIONS:

- 1) Concrete slab shall have a minimum thickness of 5" (NRS, Inc. recommends, and some areas may require 6" thickness) and placed on 4" of compacted gravel or compacted sand sub-base.
- 2) NRS, Inc. recommends that the concrete slab be reinforced with 6x6-W2.1xW2.1 welded wire fabric at 1½" concrete cover from the top. In lieu of welded wire fabric, 2" XOREX by Ribbon Technology Corporation or equal corrugated steel fibers applied at a rate of 50-lbs./Cubic Yard may be used. Nylon or polypropylene fiber are not recommended.
- 3) Crack control joints shall be sawed into slab to form approximate square patterns. The maximum spacing for control joints shall not exceed 12'-6", unless shown otherwise on this drawing. The bleacher frames shall not be set on control joints. The designer shall contact NRS to coordinate joint spacing requirements with the specific bleacher design.
- 4) The slab may be sloped a maximum of 1/8 inch per foot for drainage. The maximum overall out of level slope for the slab perpendicular to the seats (front to rear) shall not exceed 2" and parallel to the seats (end to end) shall not exceed 4".

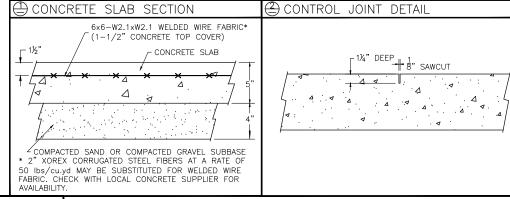

This drawing and all information contained herein is the property of NATIONAL RECREATION SYSTEMS, INC. and is not to be reproduced without express written permission of this manufacturer. We assume no responsibility for unauthorized use of this drawing. National Recreation Systems, Inc. is not responsible for local permits and occupancy requirements.

National Recreation Systems, Inc. 1300-D NORTH AIRPORT OFFICE PARK FORT WAYNE, IN 46825

SCALE: N.T.S.

DATE: 8/8/16

APPROVED BY:

DAWN BY:

JML

TITLE:

NON ELEVATED 3 ROW x 15'-0" FOUNDATION PLAN


BLEACHER MODEL #:


NB-0315GSTD

DRAWING NUMBER:

FP.

DETAIL "A" - CONC. ANCHOR ATTACHMENT

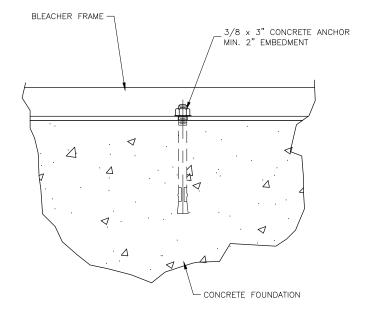

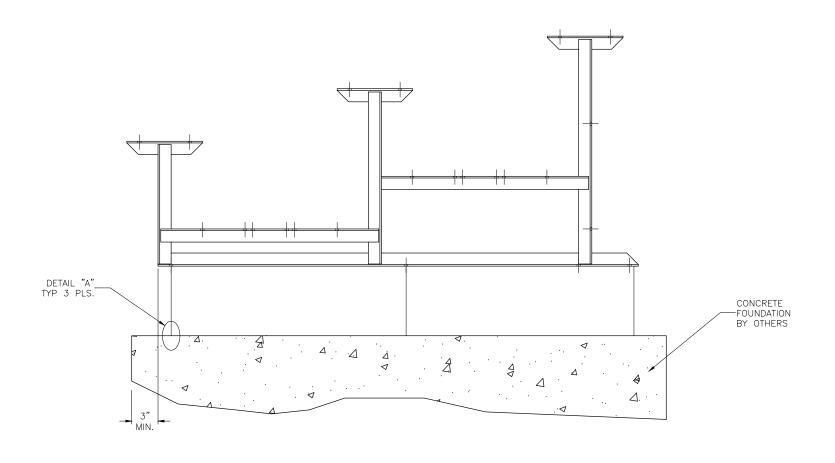

This drawing and all information contained herein is the property of NATIONAL RECREATION SYSTEMS, INC. and is not to be reproduced without express written permission of this manufacturer. We assume no responsibility for unauthorized use of this drawing. National Recreation Systems, Inc. is not responsible for local permits and occupancy requirements.

National Recreation Systems, Inc. 1300-D NORTH AIRPORT OFFICE PARK FORT WAYNE, IN 46825


				,
SCALE:	NTC	APPROVED BY:	DRAWN BY:	
	IV.1.5.			11/41
DATE:	0/0/16			JML
D,	0/0/10			


NON ELEVATED 3 ROW x 15'-0" ANCHORING PLAN
BLEACHER MODEL #: NR_03150STD | DRAWING NUMBER:


NB-0315GSTD

DETAIL "A" - GROUND SILL ATTACHMENT


DETAIL "B" - STRAP HEAD DETAIL

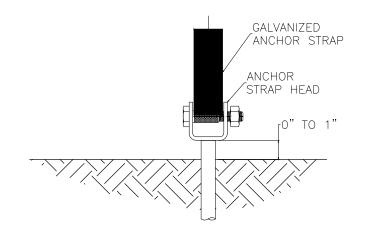

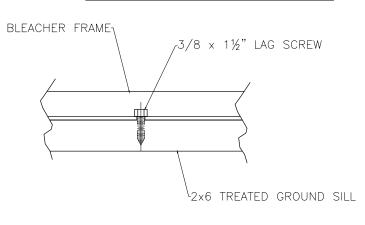

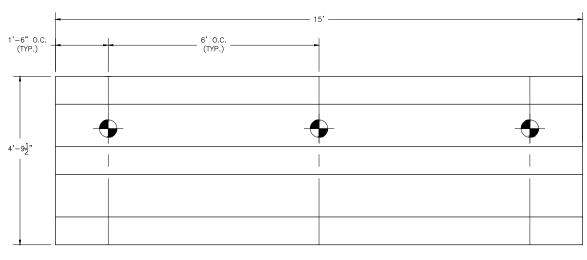

AUGER ANCHOR LOCATIONS FOR 3 ROW 15'-0" NON ELEVATED BLEACHER SYSTEM

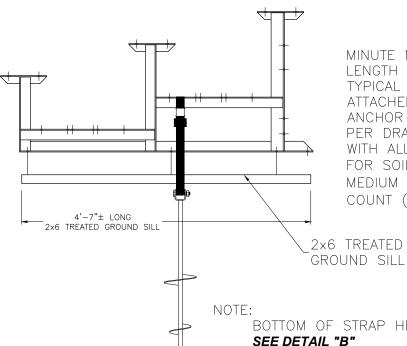

MINUTE MAN SOIL ANCHOR MARK MMA-52, MODEL 4636-DH $\frac{3}{4}$, 4 $^{\circ}$ & 6 $^{\circ}$ DISKS, 36 $^{\circ}$ LENGTH

TYPICAL ATTACHED TO BLEACHER FRAMES BY MINUTE MAN BUCKLE STRAP AND ATTACHED FROM STRAP TO

ANCHOR HEAD BY MINUTE MAN STRAP BOLT. ANCHORS SHALL BE FIELD INSTALLED AS PER DRAWINGS STARTING

WITH ALL OUTSIDE FRAMES AND ALTERNATE FRAME LINES. THE ANCHOR IS DESIGNED FOR SOILS OF "LOOSE TO

MEDIUM DENSE SANDS; FIRM TO STIFF CLAYS AND SILTS; ALLUVIAL FILLS" WITH A BLOW COUNT (ASTMD1586) OF 18-23.

BOTTOM OF STRAP HEAD TO BE SET AT GROUND LEVEL. **SEE DETAIL "B"**

This drawing and all information contained herein is the property of NATIONAL RECREATION SYSTEMS, INC. and is not to be reproduced without express written permission of this manufacturer. We assume no responsibility for unauthorized use of this drawing. National Recreation Systems, Inc. is not responsible for local permits and occupancy requirements.


National Recreation Systems, Inc.


1300-D NORTH AIRPORT OFFICE PARK FORT WAYNE, IN 46825

SCALE: N.T.S. APPROVED BY: DRAWN BY: JML

TITLE: NON ELEVATED 3 ROW x 15'-0" ANCHORING PLAN

BLEACHER MODEL #: NB-0315GSTD DRAWING NUMBER: AF

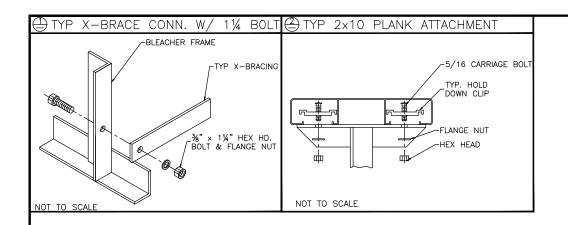

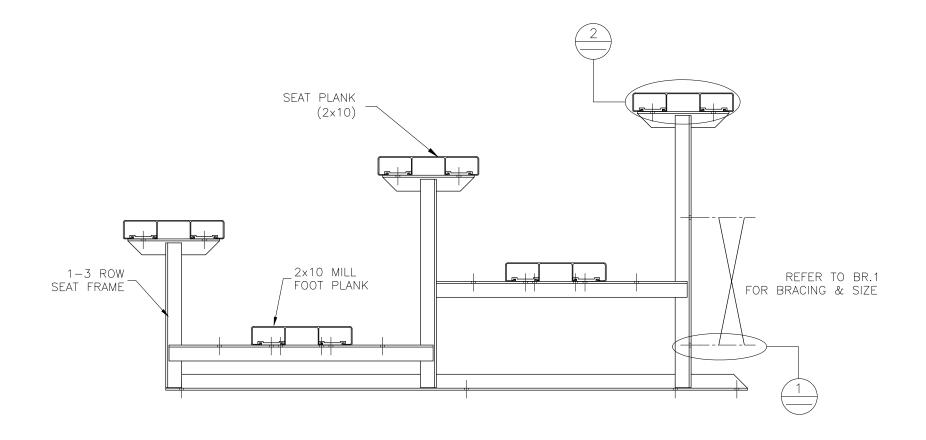

This drawing and all information contained herein is the property of NATIONAL RECREATION SYSTEMS, INC. and is not to be reproduced without express written permission of this manufacturer. We assume no responsibility for unauthorized use of this drawing. National Recreation Systems, Inc. is not responsible for local permits and occupancy requirements


National Recreation Systems, Inc.


1300-D NORTH AIRPORT OFFICE PARK FORT WAYNE, IN 46825

N.T.S. APPROVED BY: DATE: 8/8/16

NON ELEVATED 3 ROW x 15'-0" BLEACHER ASSEMBLY BLEACHER MODEL #:

NB-0315GSTD

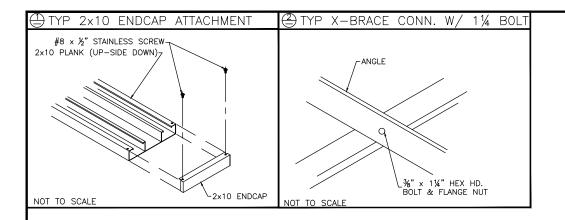

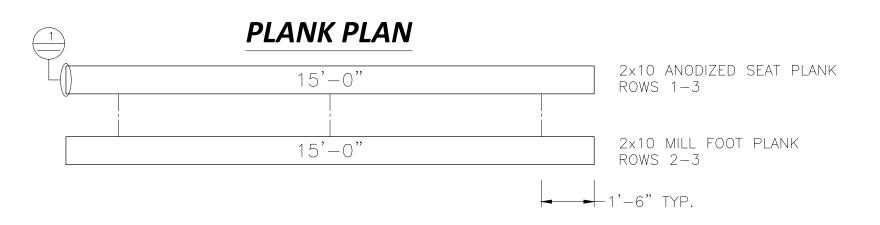

This drawing and all information contained herein is the property of NATIONAL RECREATION SYSTEMS, INC. and is not to be reproduced without express written permission of this manufacturer. We assume no responsibility for unauthorized use of this drawing. National Recreation Systems, Inc. is not responsible for local permits and occupancy requirements.

National Recreation Systems, Inc.


1300-D NORTH AIRPORT OFFICE PARK FORT WAYNE, IN 46825

SCALE: N.T.S. APPROVED BY: DRAWN BY: JML

NON ELEVATED 3 ROW x 15'-0" PLANK & FRAMING PLAN

BLEACHER MODEL #: NB-0315GSTD PRAWING NUMBER:

PF.

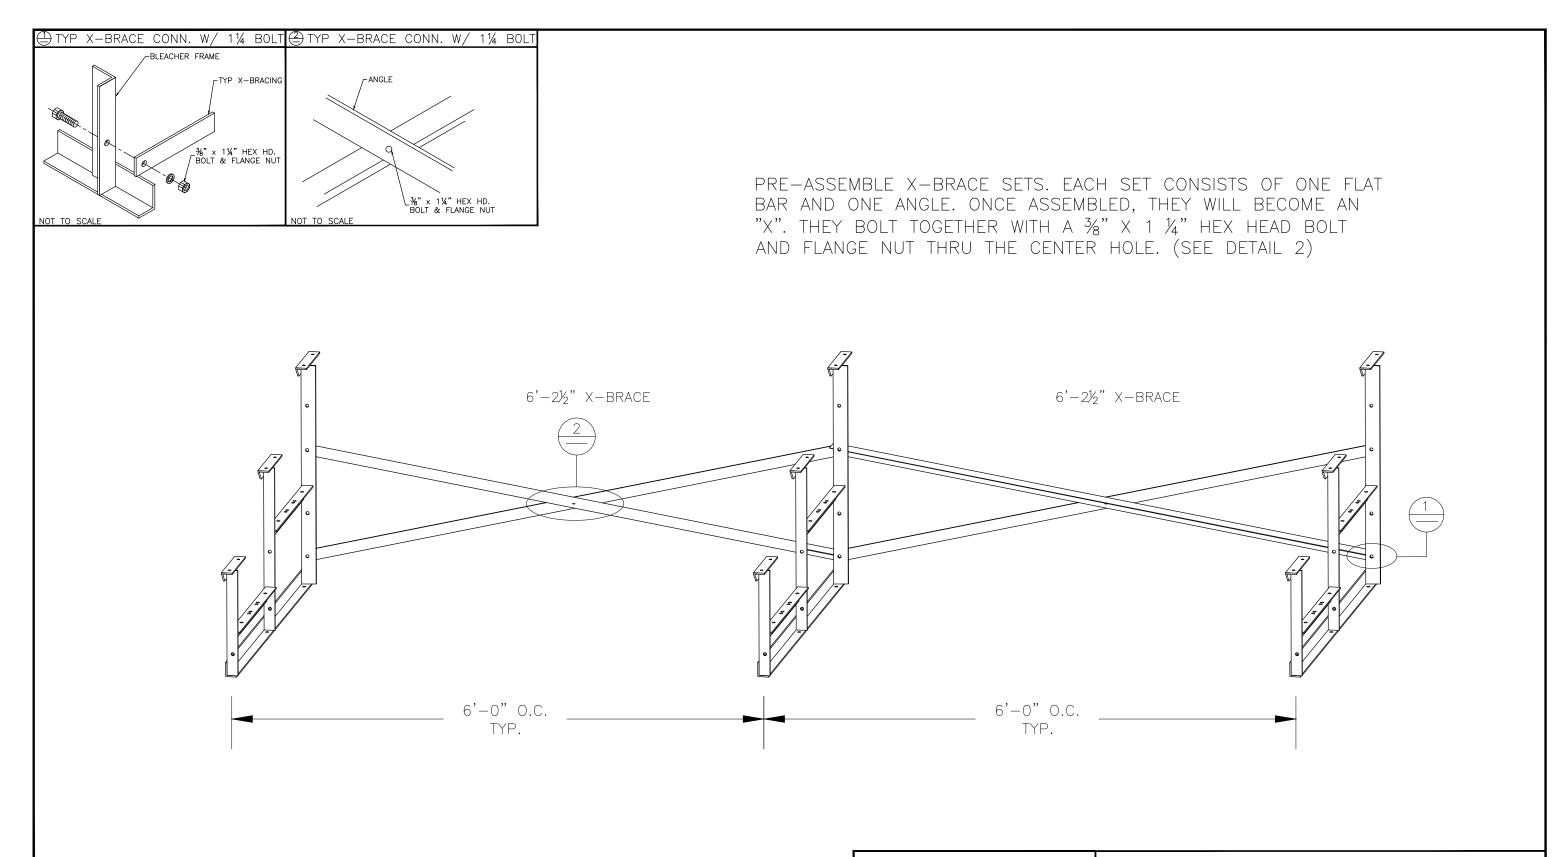

This drawing and all information contained herein is the property of NATIONAL RECREATION SYSTEMS, INC. and is not to be reproduced without express written permission of this manufacturer. We assume no responsibility for unauthorized use of this drawing. National Recreation Systems, Inc. is not responsible for local permits and occupancy requirements.

National Recreation Systems, Inc. 1300-D NORTH AIRPORT OFFICE PARK FORT WAYNE, IN 46825

1300-D NORTH AIRPORT OFFICE PARK FORT WAYNE, IN 4682

SCALE: N T C | APPROVED BY: | DRAWN BY:

	14.1.0.		1 1 1 1 1 1 1 1 1 1 1 1 1 1 1 1 1 1 1 1
DATE: {	3/8/16		JIVIL
TITLE:		BRACING	
BLEACHER	MODEL #:	NR-0315GSTD	DRAWING NUMBER: